18.12.23 DA ISSUE REV

DUAL OCCUPANCY (STRATA)

CLIENT: TICKLE & ROUND

STATUS: DA ISSUE

LOT No: 6 **DP No:** 1297305

STREET NAME: 1-3 FERRY ROAD, OXLEY ISLAND

CWC JOB #: A5558 & A5563 CONTENTS SHEET # SHEET NAME REVISION

LEGENDS SITE PLAN S68 & S138 PLAN FLOOR PLANS SHED DETAILS **ELEVATIONS** ROOF PLAN DRAFT SUB-DIVISION 3D VIEWS AND PERSPECTIVES CONSTRUCTION NOTES BUILDING SPECIFICATIONS & WORK SAFETY NOTES





GENERIC | TYPICAL KEY, LEGEND AND ABBREVIATIONS FOR COLLINS W COLLINS ARCHITECTURAL PLANS

THESE NOTES MUST BE READ AND UNDERSTOOD BY ALL INVOLVED IN THE PROJECT. THIS INCLUDES (but is not limited to): OWNER, BUILDER, SUB-CONTRACTORS, CONSULTANTS, RENOVATORS, OPERATORS, MAINTAINERS, DEMOLISHERS. PLEASE USE THIS IN CONJUNCTION WITH ALL DRAWING SHEETS AND VIEWS CONTAINED FORTHWITH IN THIS PLAN SET. REVISED JANURARY 2021

SYMBOLS AND LINES

LOT BOUNDARY

SITE PLAN | S68 S138 PLAN

— - - — STORMWATER LINE — — - — WATER CONNECTION LINE — — DOWNPIPE TO WATER TANK — — — DOWNPIPE FROM TANK TO APPLIANCE ----- SILTATION CONTROL FENCING SITE HOARDING FENCING ----- BATTER EXTREMITIES LINE

— — EASEMENT BOUNDARY - - - - OVERHEAD POWER LINES

FLOOR PLANS / SECTIONS (INCL SETOUT, ROOF, DETAIL CALL OUTS) — — — OVERHEAD ITEM - — — — DEMOLITION LINE ———— UPPER FLOOR OUTLINE

— — — ROOF OUTLINE OVER ----- RAKED CEILING LINE — — — — BEAM LINE SQUARE SET OPENING TERMITE PROTECTION: TO A.S 3660.1

— — — NATURAL GROUND LINE (EXCAVATED) COLUMN (MATERIAL AS PER SCHEDULE OR PLAN) MASONRY PIER (SIZE AS PER SCHEDULE OR PLAN) ENGAGED PIERS: TO COMPLY WITH AS 4773.1-2010 & AS 4773 2-2010 INSULATION BATTING TO BE DEMOLISHED / REMOVED

GENERAL SYMBOLS AND ARCHITECTURAL SYMBOLS NORTH W01

DOOR TAG (DA/CC) RENOVATION / DEMOLITION SYMBOLS TO BE DEMOLISHED OR REMOVED

EXISTING ITEM / ELEMENT (FLOOR/WALLS/WINDOWS ETC) PROPOSED NEW ITEM / ELEMENT GENERAL ABBREVIATIONS AVERAGE RECURRANCE INDEX

AUSTRALIAN HEIGHT DATUM CROSS LAMINATED TIMBER COST OF WORKS DOUBLE GENERAL POWER OUT! FT DOUBLE HUNG WINDOW RAINWATER DOWNPIPE DOUBLE TOWEL RAIL

FINISHED SURFACE LEVEL

FALL OF BATTER SLOPE

GARDEN TAP WATER METER / ALTERNATE WATER METER

TEMPORARY HOARDING GATES

STREET TREE / SITE TREE

LIGHT POLE POWER POLE

FILL (TO ENGINEERS DETAIL) WET AREA TILED FLOOR SURFACE COMMON / OUTDOOR TILED FLOOR SURFACE BROOM FINISH CONCRETE FLOOR SURFACE

CONCRETE TIMBER/METAL STUD FRAMED WALL CONCRETE BLOCK WALL MASONRY VENEER WALL

METAL SHEET ROOFING KLIP-LOK (OR SIMILAR) METAL SHEET ROOFING WAFFLE POD (TO ENGINEERS DETAIL) TACTILE GROUND SURFACE INDICATORS: TO AS 1428.4.1:2009

STAIRS INCLUDING DIRECTION OF TRAVEL (UP) RAMP INCLUDING DIRECTION OF TRAVEL (UP)

TYPICAL SECTION MARKER TYPICAL ELEVATION MARKER

TYPICAL CALL OUT MARKER VIEW TAG AND SCALE VIEW SCALE

908

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MULTI STOREY SITE PLAN SYMBOLS / LEGEND

- - - TO BE DEMOLISHED OR REMOVED EXISTING AREA / FACADE / ROOM

FIXED GLASS / PANEL FIXED GLASS WINDOW GLUE LAMINATED TIMBER GENERAL POWER OUTLET HOT WATER SERVICE LOCAL ENVIRONMENT PLAN

LIFT OFF HINGE LAMINATED VENEER LUMBER

MECHANICAL ELECTRICAL METER BOX MOISTURE RESISTANT MAN HOLE

LOH

MECH.

PLASTER BOARD REINFORCED CONCRETE REDUCED LEVEL SURFACE LEVEL STORM WATER

MIDDLE FLOOR

UPPER FLOOR

ELECTRICAL CUBICLE / PIT

TELECOMMUNICATIONS PIT

⊢ GTAP GARDEN TAP

TO BE DEMOLISHED / REMOVED

RAINWATER DOWNPIPES: TO AS 3500

SLIDING DOOR UNIT OPENING DIRECTION

SLIDING WINDOW OPENING DIRECTION

GAS INSTANTANEOUS HOT WATER SERVICE

LOWEST FLOOR (GROUND TYPICAL)

HINGED DOOR OPENING DIRECTION

GAS BOTTLES

ELECTRICAL METER BOX

SOLAR HOT WATER SERVICE

HOT WATER TANK

COOKTOP

AWNING/CASEMENT WINDOW OPENING DIRECTION

SMOKE ALARMS TO AS3786 AND NCC, VOL. 2, PART H3D6 AND PART 9.5 OF THE SMOKE ALARMS:

ABGE HOUSING PROVISIONS, ALL ALARMS/DETECTORS ARE TO BE INTERCONNECTED. LOCATIONS ON PLANS ARE INDICATIVE, INSTALLATION TO BE AS PER STANDARDS ABOVE, AND MANUFACTURERS SPECIFICATIONS

MECHANICAL VENTILATION: MECHANICAL VENTILATION EXTERNALLY DUCTED TO COMPLY WI VOL. 2, PART H4D7 AND PART 10.6 AND 10.8.2 OF THE ABCB HOU

TRH TOILET ROLL HOLDER T.O.K TOP OF KERB T.O.W TOP OF WALL

900V **VANITY SIZING** INTERIOR DOOR SIZING

BATH SIZING

1650B

10 STAR **ASSESSMENTS**

10 Star Building Assessments Forster, NSW 2428 / Sydney, East Gardens NSW 2036, NSW admin@10sba.com www.10sba.com 048 1010 999

LOT # DP#

16 Aug 2023

NaTHERS REQUIREMENTS PLAN STAMP - ESD-NAT-070823-A5558

NaTHERS requirements set out below are part of the requirements to achieve final occupation certification.

Any items that are changed or altered require a new NatHERS certificate to be issue.

Compliance with this is required to be demonstrated upon completion to the certifying authority. The Certifier must confirm that these commitments have been installed and not altered.

PROJECT DETAILS

A5558 1-3 Ferry Rd Oxley Island NSW 2430 Lot 5 **ENERGY RATING** STAR RATING **DWELLING #** HEATING LOAD COOLING LOADS Unit 02 36.0 14.1 29.1 Unit 01 21.2

SUBURB / TOWN / POST CODE

FLOORS

FLOOR TYPE	ADDITIONAL INSULATION	OTHER INFORMATION
100mm concrete slab on ground	R1.0	(Dwl 02) cellar, entry, media, butlers, hallway
100mm concrete slab on ground	R1.0	Dwl 01
FLOOR COVERINGS	11110	J

FLOOR COVERINGS				
AREA	COVERING	OTHER INFORMATION		
GENERALLY -	CONCRETE EXPOSED			
WET AREAS	TILE			

WALL INSULATION

WALL INSOLATION				
WALL TYPE	ADDITIONAL INSULATION	OTHER INFORMATION		
SCYIN LINEAR -	R2.70	(MODELLED AS DIRECT FIXED)		
HARDI FINE TEXTURE CLADDING	R2.70	(MODELLED AS DIRECT FIXED)		
75MM EPS	R2.70	(MODELLED AS DIRECT FIXED)		
BRICK VENEER - REFL CAV	R2.70			
РВ	R1.5	WALLS ADJACENT GARAGE, LDRY, BATH, WC		
РВ	R4.0	WALLS TO ROOF SPACES		
	SCYIN LINEAR - HARDI FINE TEXTURE CLADDING 75MM EPS BRICK VENEER - REFL CAV PB	SCYIN LINEAR - R2.70 HARDI FINE TEXTURE CLADDING 75MM EPS R2.70 BRICK VENEER - REFL CAV R2.70 PB R1.5		

ROOF AND CEILINGS

SOLAR ABSORPTANCE

ROOF CONSTRUCTION TYPE	INSULATION	OTHER INFORMATION
METAL	R1.3 ANTICON BLANKET	

MEDIUM (0.475-0.70)

NaTHERS REQUIREMENTS PLAN STAMP - ESD-NAT-070823-A5558 Page 1

Version: 10

SOLAR ABSORPTANCE

OTHER INFORMATION **CEILING TYPE** INSULATION LINED ADJACENT TO EXTERNAL AREAS R4.0

LIGHT (0.30-0.475)

WINDOWS AND GLAZING

WINDOW DESCRIPTION	FRAME TYPE	U VALUE	SHGC	
HINGED DOOR (DWL 1 GD03)	ALM - SG - LOWE - CLEAR	4.75	0.41	
SLIDING WINDOW (DWL 1)	ALM - SG - LOWE - CLEAR	4.94	0.52	
DOUBLE HUNG (DWL 1 W13), (DWL 2)	ALM - SG - LOWE - CLEAR	4.75	0.52	
FIXED (DWL 1), (DWL 2)	ALM - SG - LOWE - CLEAR	3.93	0.63	
FIXED - ENTRY WINDOWS, - (DWL1), (DWL2)	ALM - DG - LOWE - CLEAR	2.14	0.53	
LOUVRE (DWL 1), (DWL 2)	ALM - SG - LOWE - CLEAR	4.66	0.49	
ENTRY DOOR (DG06 DWL1), (DWL 2 ENTRY DOOR)	ALM - DG - LOWE - CLEAR	3.42	0.47	
SLIDING DOOR - (GD04 DWL 1), (DWL 2 GD01)	ALM - DG - LOWE - CLEAR	3.39	0.44	
AWNING (DWL2, W01, W02)	ALM - SG - LOWE - CLEAR	5.27	0.47	
HINGED DOOR (DWL 2 GD02)	ALM - SG - CLEAR	5.82	0.53	
AWNING (DWL 2 W04)	ALM - DG - CLEAR	4.32	0.55	

SOLAR ABSORPTANCE

AREA	TYPE	SIZE
ANEA		
LIVING ROOM	CEILING FAN	1500 DIA
BEDROOMS 2, 3, 4	CEILING FAN	900 DIA
M BEDROOM	CEILING FAN	1200 DIA
KITCHEN, ENSUITE, BATHROOM	EXHAUST FAN	MAX 250 X 250 (SEALED)
FIRE PLACE (DWL 2)	N/A	MAX 250 X 250 (SEALED and INSULATED)

MEDIUM (0.475-0.70)


LIGHTING

DESCRIPTION	OTHER INFORMATION
NO LIGHTING PLANS PROVIDED	

NaTHERS REQUIREMENTS PLAN STAMP - ESD-NAT-070823-A5558

Page 2 Version: 10



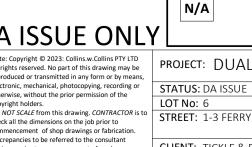

BUSHFIRE NOTES: NOT BUSHFIRE AFFECTED FURTHER INFORMATION. PLEASE REFER TO THE BASIX CERTIFICATE FOR N/A EXACT DETAILS LEGENDS

GENERAL PLAN SET NOTES: PLEASE REFER TO THE "SUMMARY OF BASIX COMMITMENTS" ON PAGE 2 FOR CHECK ALL DIMENSIONS ON SITE. THIS DRAWING IS TO BE READ IN CONJUNCTION WITH ALL RELEVANT CONTRACTS, SPECIFICATIONS, REPORTS, DRAWINGS, LEGENDS, NATIONAL CONSTRUCTION CODE, AUS & NZ STANDARDS, ENGINEERING & COUNCIL APPROVALS

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PROJECT: DUAL OCCUPANCY (STRATA) SHEET SIZE: DRAWING REVISIONS + NOTES 04.08.23 INITIAL ISSUE SHEET: 1 OF 8 SCALE: 1:100 LOT No: 6 **DP No:** 1297305 10.10.23 REVISED right holders.


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STREET: 1-3 FERRY ROAD, OXLEY ISLAND **A**1 07.12.23 DA ISSUE **START DATE**: 13.04.23 11.12.23 DA ISSUE 18.12.23 DA ISSUE REV **CLIENT:** TICKLE & ROUND A5558 & A5563 DWG No:

AREAS - GROSS FLOOR AREA (GFA)			
*MEASURED FROM INTERNAL FACE OF EXTERNAL WALL *EXLUDES STAIRS/VOIDS FROM UPPER FLOORS *EXCLUDES REQUIRED CAR PARKING SPACE (IE. 18m² FOR SINGLE CAR)			
NAME	AREA		
GRG GFA AREA	43.1 m²		
GFA AREA	251.6 m ²		
GFA AREA	278.9 m²		
CDC CEA ADEA	40.9 m ²		
GRG GFA AREA			

SITE PLAN





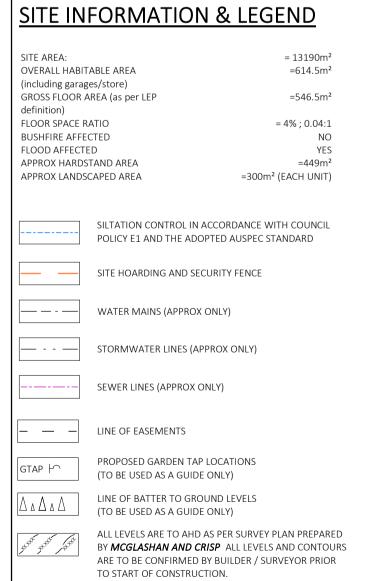

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LEASE REFER TO THE "SUMMARY OF BASIX COMMITMENTS" ON PAGE 2 FOR CHECK ALL DIMENSIONS ON SITE. THIS DRAWING IS TO BE READ IN JRTHER INFORMATION. PLEASE REFER TO THE BASIX CERTIFICATE XACT DETAILS

SITE PLAN

As indicated

START DATE: 13.04.23

DWG No: A5558 & A5563

SHEET: 2 OF 8 SCALE:

GENERAL PLAN SET NOTES:

	BOSHFIRE NOTES:	BASIA
	NOT BUSHFIRE AFFECTED	PLEAS
	10/0	FURT
	N/A	EXAC
A ISSUE ONLY	<u> </u>	
ote: Copyright © 2023: Collins.w.Collins PTY LTD	PROJECT: DUAL OCCUPANCY (STRATA)	

DP No: 1297305


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NOT SCALE from this drawing. CONTRACTOR is to eck all the dimensions on the job prior to mmencement of shop drawings or fabrication. screpancies to be referred to the consultant

CLIENT: TICKLE & ROUND

ΓE FOR	REPORTS,	TION WITH ALL RELEVANT CONTRACTS, SPECIFICATIONS, DRAWINGS, LEGENDS, NATIONAL CONSTRUCTION CODE, STANDARDS, ENGINEERING & COUNCIL APPROVALS			
	SHEET SIZE:	DRAWIN	G REVISIONS + NOTES		
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	\mathcal{A}	11.12.23	DA ISSUE	E	AE
		18.12.23	DA ISSUE REV	F	AE





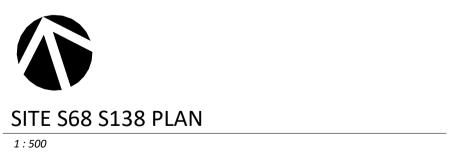

DWG No:

A5558 & A5563

CLIENT: TICKLE & ROUND

rior to commencement of work.

U1: SUMMARY BASIX COMMITMENTS U2: SUMMARY BASIX COMMITMENTS

WATER COMMITMENTS

ENERGY COMMITMENTS

NDIVIDUAL 10,000 L INDVIDUAL ROOF 408m²
VATER TANK: COLLECTION:

Ceiling Fans in at least 1 inving room and 1 beauton 1-phase air-conditioning in at least 1 living room ai bedroom (3.5 Avg Star Rating, day/night zoned between living and bedrooms)

*REFER TO BASIX CERTIFICATE FOR EXACT DETAILS AND REQUIREMEN

*REFER TO BASIX CERTIFICATE FOR EXACT DETAILS AND REQUIREMENT

 NAME
 AREA

 1 ROOF AREA
 410.4 m²

 1 SHED ROOF AREA
 100.0 m²


 2 ROOF AREA
 404.6 m²


SHED ROOF AREA 100.0 m²


AREAS - ROOF AREAS

ABEL MATERIAL DESCRIPTION NG(L) LONGLINE STANDING SEAM METAL SHEET ROOFING (LIGHT) RENDERED NRG FOAM PANEL (SEE CC NOTES) SELECT VERTICAL PROFILE CLADDING

EXTERNAL FINISHES

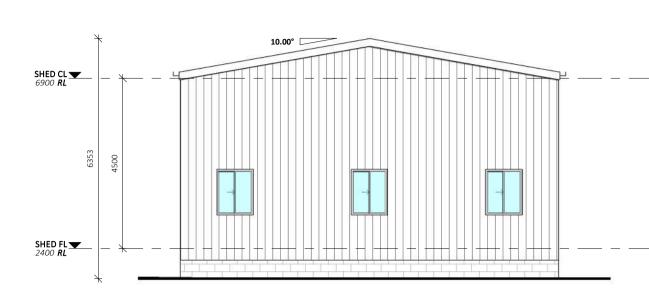

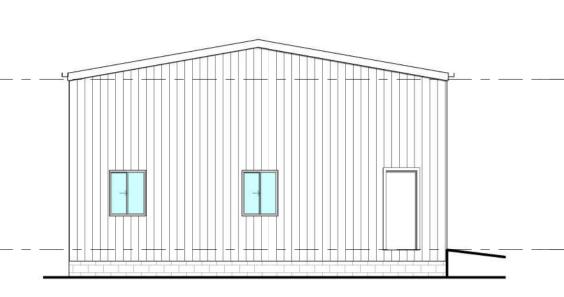

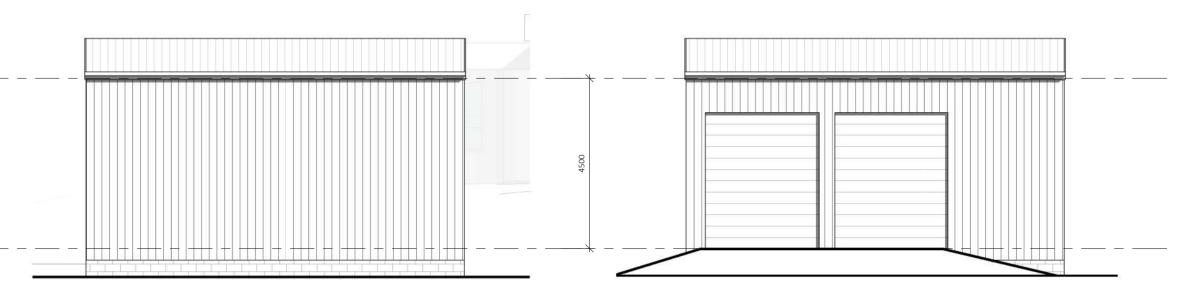


U1 SHED STH ELEVATION 1:100

U1 SHED NORTH ELEVATION 1:100

U1 SHED EAST ELEVATION 1:100

U1 SHED WEST ELEVATION 1:100

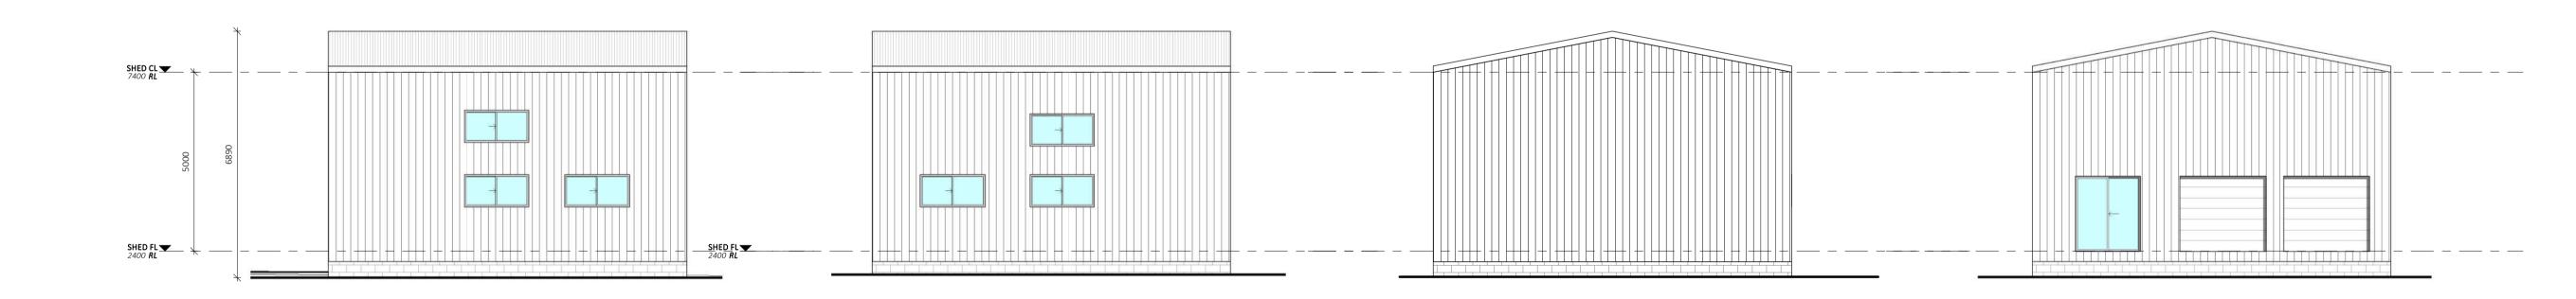

U2 SHED SOUTH ELEVATION

U2 SHED NORTH ELEVATION

1:100

U2 SHED EAST ELEVATION

BUSHFIRE NOTES:

N/A

NOT BUSHFIRE AFFECTED

U2 SHED WEST ELEVATION

CONSTRUCTION NOTES:

STAIRS, RAMPS, HANDRAILS & BALUSTRADE NOTES: STAIRS TO COMPLY WITH NCC VOL. 2, H5D2 AND PART 11.2.2 OF THE ABCB HOUSING PROVISIONS. RAMPS TO COMPLY WITH PART 11.2.3. SLIP RESISTANCE TO STAIRS AND RAMPS AS PER PART 11.2.4 OF THE ABCB HOUSING PROVISIONS AND IN ACCORDANCE WITH

BARRIERS AND HANDRAILS TO BE NO LESS THAN 1000mm FROM PROPOSED FINISHED FL. BALUSTRADE & HANDRAIL TO BE IN ACCORDANCE WITH NCC, VOL. 2, H5D3 AND PARTS 11.3.3, 11.3.4, 11.3.5 AND 11.3.6 OF THE ABCB HOUSING PROVISIONS. WINDOW NOTES:

BEDROOM WINDOWS - WHERE THE FLOOR LEVEL OF A BEDROOM IS 2M OR MORE ABOVE THE SURFACE BENEATH, BEDROOM WINDOWS ARE TO COMPLY WITH NCC, VOL. 2, H5P2 AND PART 11.3.7 OF THE ABCB HOUSING PROVISIONS

WINDOWS - WHERE THE FLOOR LEVEL IS 4m OR MORE ABOVE THE SURFACE BENEATH, WINDOWS ARE TO COMPLY WITH NCC, VOL. 2, H5P2 AND PART 11.3.8 OF THE ABCB HOUSING PROVISIONS. BARRIER WITH A HEIGHT OF NOT LESS THAN 865mm ABOVE FLOOR IS REQUIRED TO AN OPENABLE WINDOW TO COMPLY WITH VOL 2 NCC PART 3.9.2.6 (c) & 3.9.2.7 (b)

WIND CATEGORY TO BE CONFIRMED PRIOR TO START OF CONSTRUCTION. IF N2 OR HIGHER, ENGAGED PIERS TO BRICKWORK AREA'S ARE TO COMPLY WITH AS 4773.1-2010 & AS 4773 2-2010

AS 1288 : GLASS IN BUILDING - SELECTION & INSTALLATION AS 2047 : WINDOWS & EXTERNAL DOORS IN BUILDING AS 1170-Part 2: WIND ACTIONS AS 3959: CONSTRUCTION OF BUILDINGS IN BUSHFIRE *THE STANDARDS REFERRED ABOVE ARE THE VERSION ADOPTED BY THE NCC AT THE TIME THE RELEVANT

PLEASE REFER TO THE "SUMMARY OF BASIX COMMITMENTS" ON PAGE 2 FOR

FURTHER INFORMATION. PLEASE REFER TO THE BASIX CERTIFICATE FOR

CONSTRUCTION CERTIFICATE OR COMPLYING
DEVELOPMENT CERTIFICATE APPLICATION IS MADE. GENERAL PLAN SET NOTES: CHECK ALL DIMENSIONS ON SITE. THIS DRAWING IS TO BE READ IN CONJUNCTION WITH ALL RELEVANT CONTRACTS, SPECIFICATIONS,

GLAZING SPECIFICATIONS:

NSTALLED ON SITE

/INDOWS SPECIFIED USE NFRC UW & SHGCW VALUES.

/INDOWS AS SPECIFIED OR EQUIVALENT MUST BE

NDARD GLAZING: SINGLE CLEAR GLAZING WITH NDARD ALUMINIUM FRAMES THROUGHOUT

THER STRIPPING TO BE INSTALLED THROUGHOUT.

EASE NOTE: ALL GLAZING IN BATHROOMS, ENSUITES,

PA ROOMS OR THE LIKE TO COMPLY WITH THE NCC, VOL.

H1D8 AND PART 8.4.6 OF ABCB HOUSING PROVISIONS

PROOM WINDOWS - WHERE THE FLOOR LEVEL OF A

BEDROOM IS 2M OR MORE ABOVE THE SURFACE BENEATH, BEDROOM WINDOWS ARE TO COMPLY WITH NCC, VOL. 2,

NDOWS - WHERE THE FLOOR LEVEL IS 4m OR MORE

OMPLY WITH NCC, VOL. 2, H5P2 AND PART 11.3.8 OF THE

ABOVE THE SURFACE BENEATH, WINDOWS ARE TO

RRIER WITH A HEIGHT OF NOT LESS THAN 865mm

ABOVE FLOOR IS REQUIRED TO AN OPENABLE WINDOW TO COMPLY WITH VOL 2 NCC PART 3.9.2.6 (c) & 3.9.2.7 (b)

WINDOWS AND GLAZING TO COMPLY WITH:

ABCB HOUSING PROVISIONS.

AS 4055: WIND LOADS FOR HOUSING

5P2 AND PART 11.3.7 OF THE ABCB HOUSING PROVISIONS



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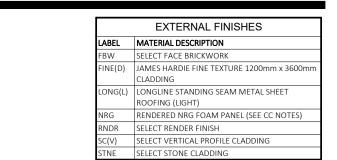
SHED DETAILS PROJECT: DUAL OCCUPANCY (STRATA) STATUS: DA ISSUE SHEET: 4 OF 8 | SCALE: 1:100 peringh holders.

2 NOT SCALE from this drawing. CONTRACTOR is to seek all the dimensions on the job prior to ammencement of shop drawings or fabrication. iscrepancies to be referred to the consultant LOT No: 6 **DP No**: 1297305 **START DATE:** 13.04.23 CLIENT: TICKLE & ROUND DWG No: A5558 & A5563

EXACT DETAILS

REPORTS, DRAWINGS, LEGENDS, NATIONAL CONSTRUCTION CODE, AUS & NZ STANDARDS, ENGINEERING & COUNCIL APPROVALS SHEET SIZE: DRAWING REVISIONS + NOTES 04.08.23 INITIAL ISSUE 10.10.23 REVISED **A**1 07.12.23 DA ISSUE

11.12.23 DA ISSUE 18.12.23 DA ISSUE REV



GLAZING SPECIFICATIONS:

07.12.23 DA ISSUE


11.12.23 DA ISSUE 18.12.23 DA ISSUE REV

START DATE: 13.04.23


DWG No:

A5558 & A5563


WINDOWS SPECIFIED USE NFRC UW & SHGCW VALUES. WINDOWS AS SPECIFIED OR EQUIVALENT MUST BE

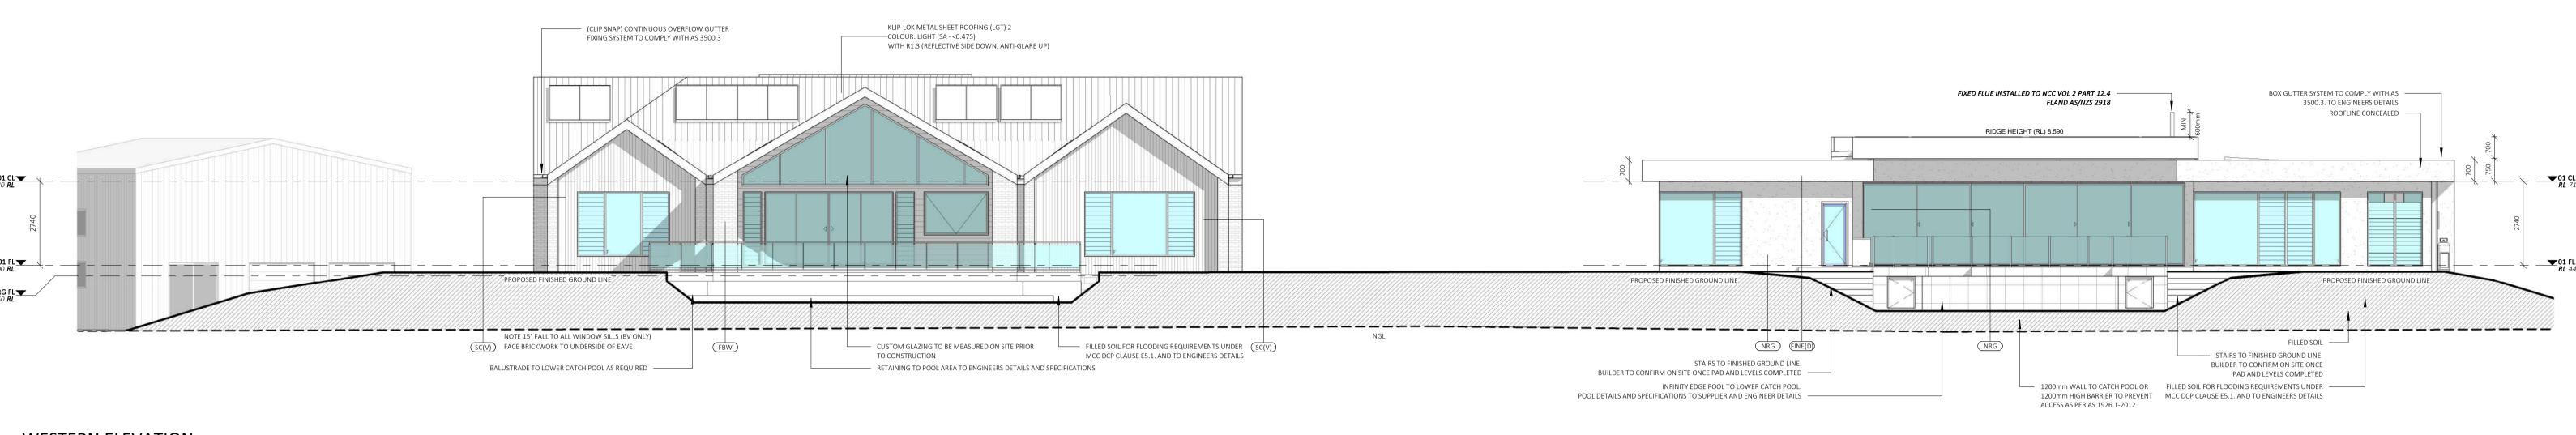

WESTERN ELEVATION

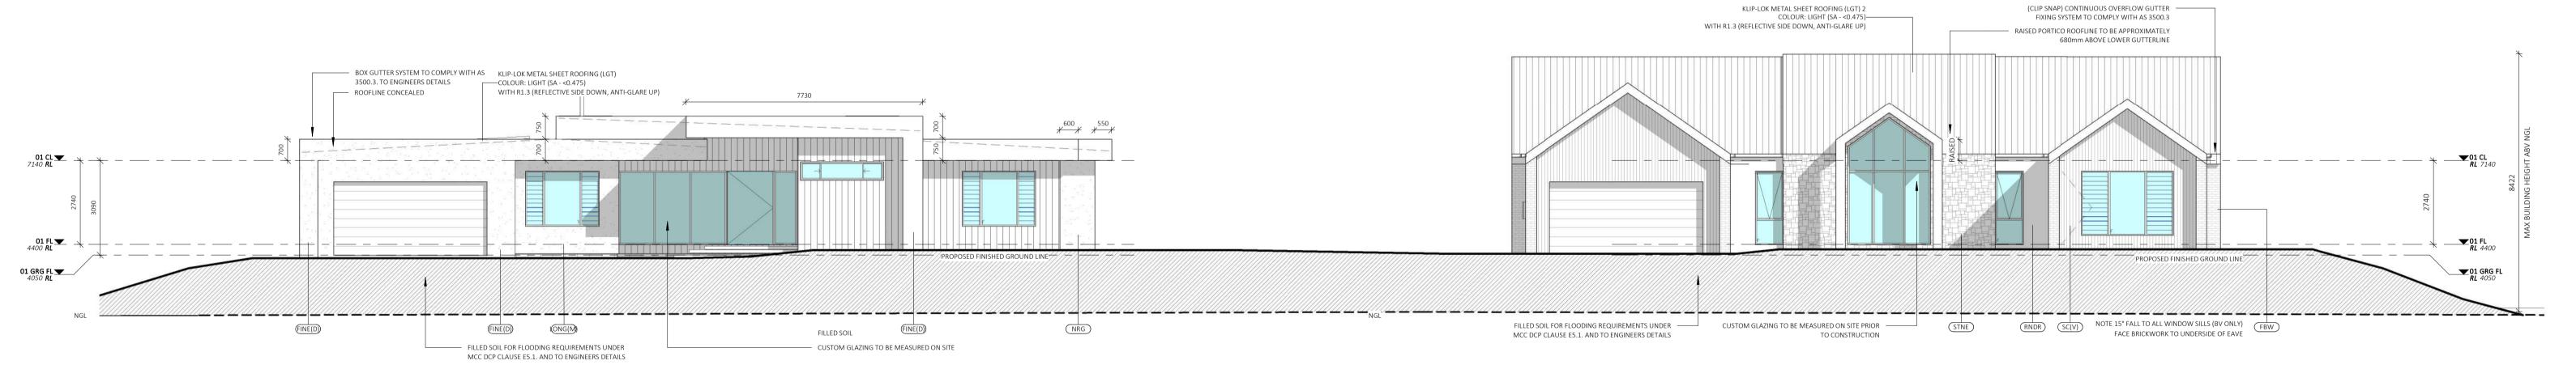

EASTERN ELEVATION

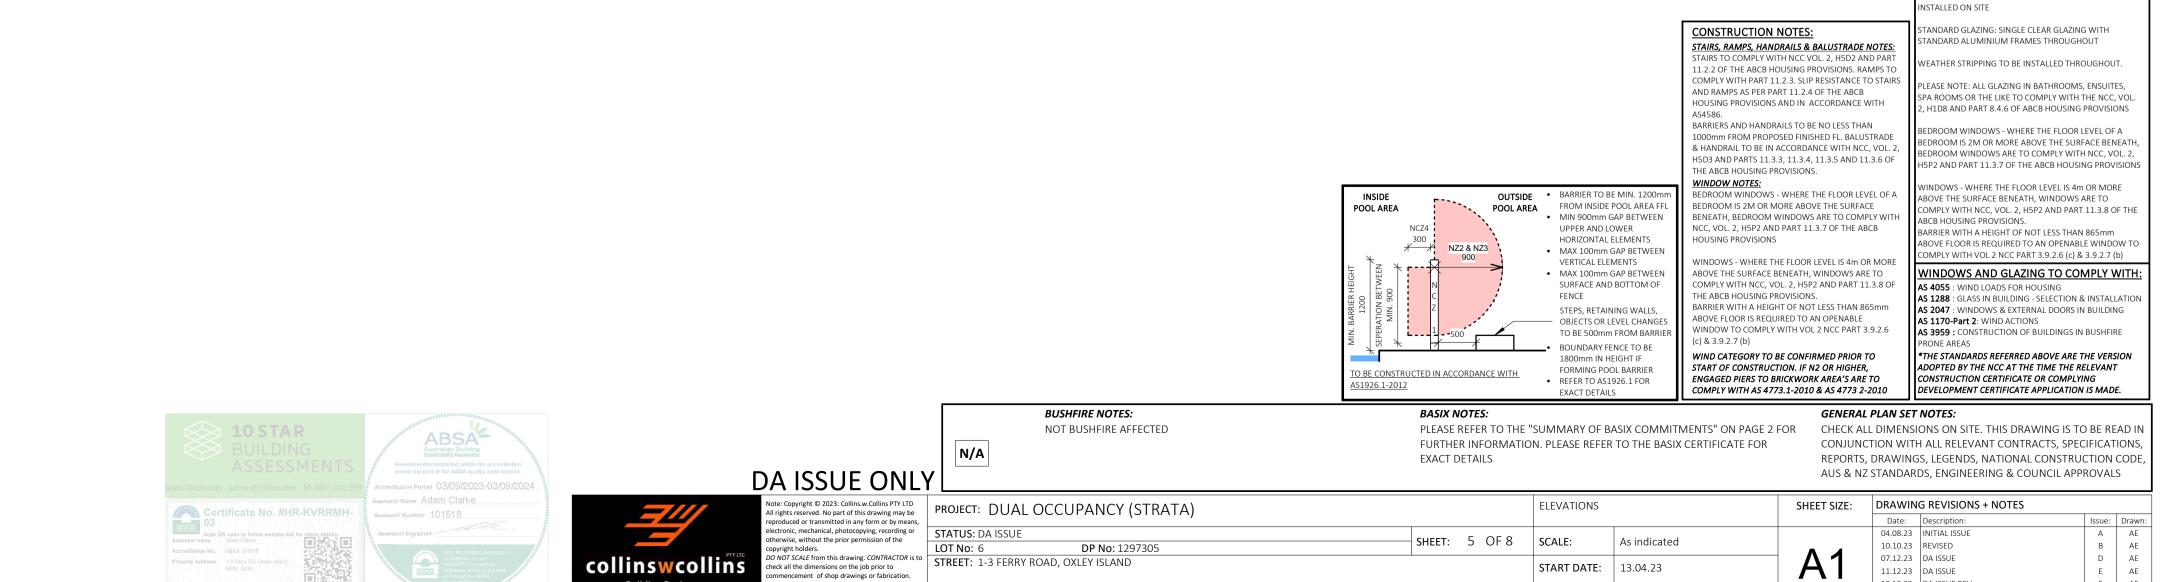

I the dimensions on the job prior to neement of shop drawings or fabrication


ancies to be referred to the consultant

rior to commencement of work.

CLIENT: TICKLE & ROUND


EXTERNAL FINISHES MATERIAL DESCRIPTION E(D) JAMES HARDIE FINE TEXTURE 1200mm x 3600 CLADDING

DNG(L) LONGLINE STANDING SEAM METAL SHEET ROOFING (LIGHT) RENDERED NRG FOAM PANEL (SEE CC NOTES) SELECT VERTICAL PROFILE CLADDING

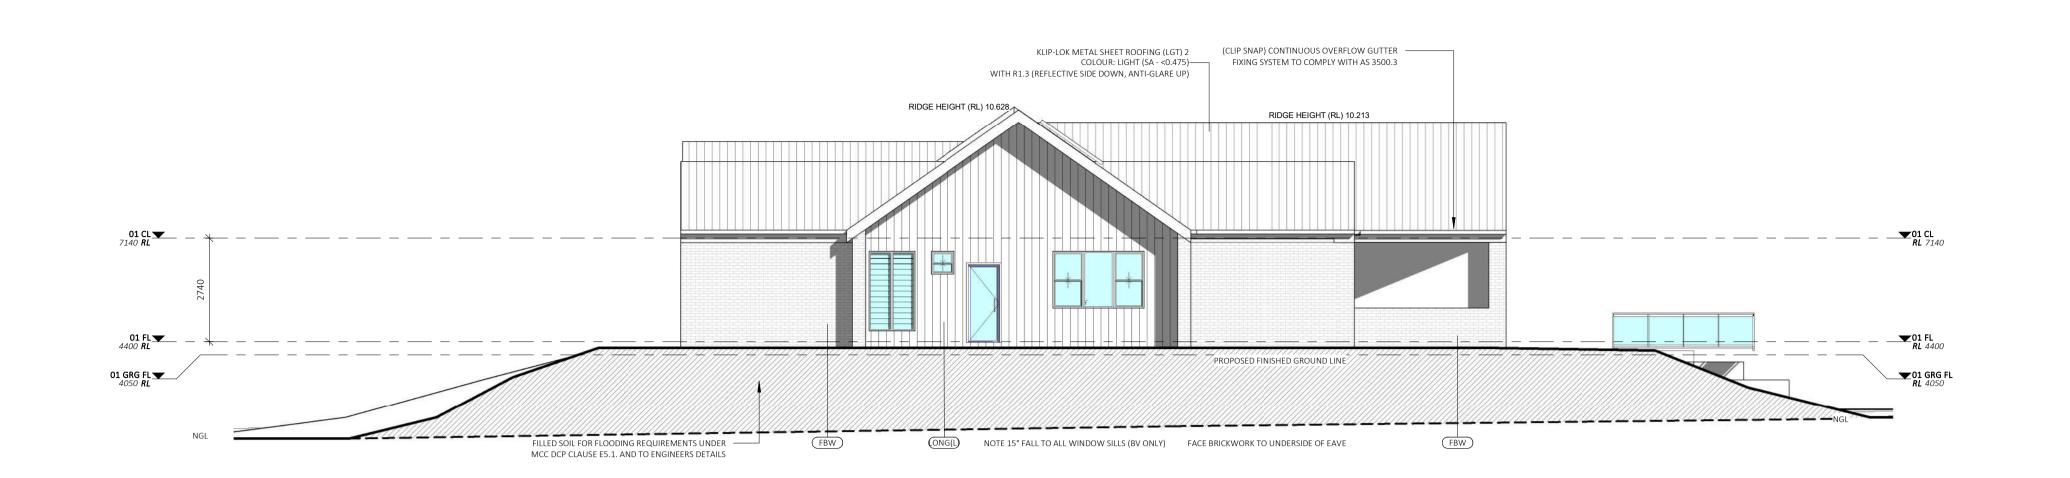




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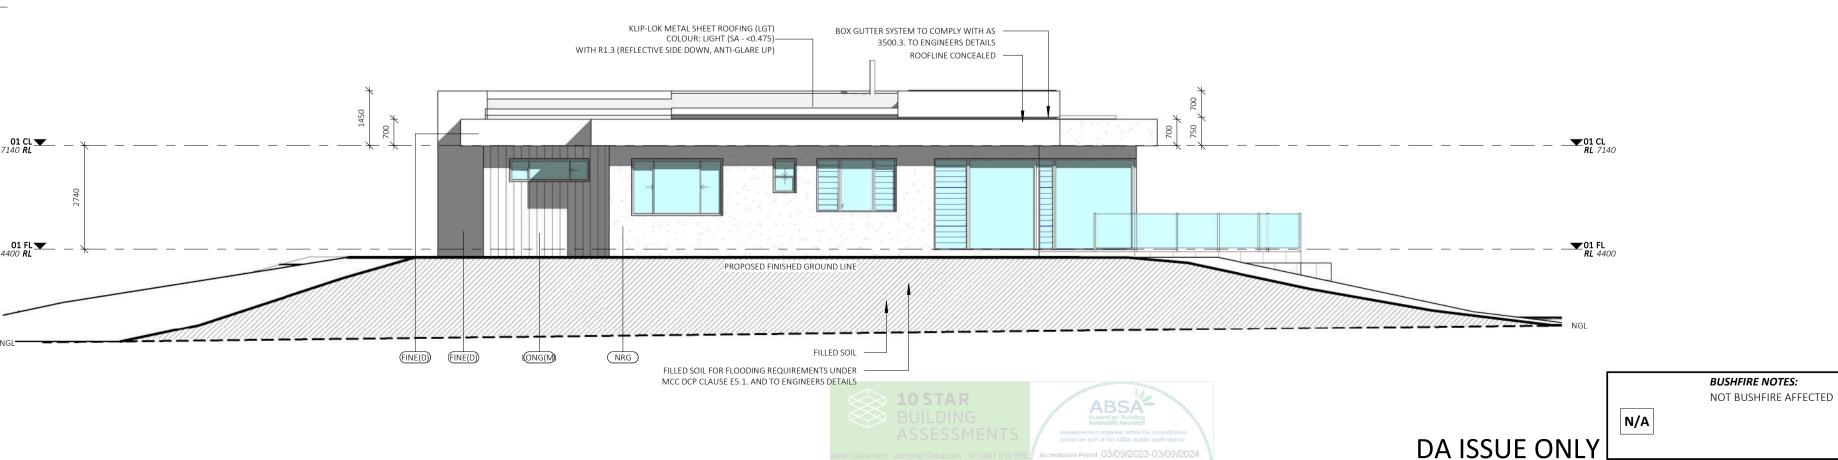


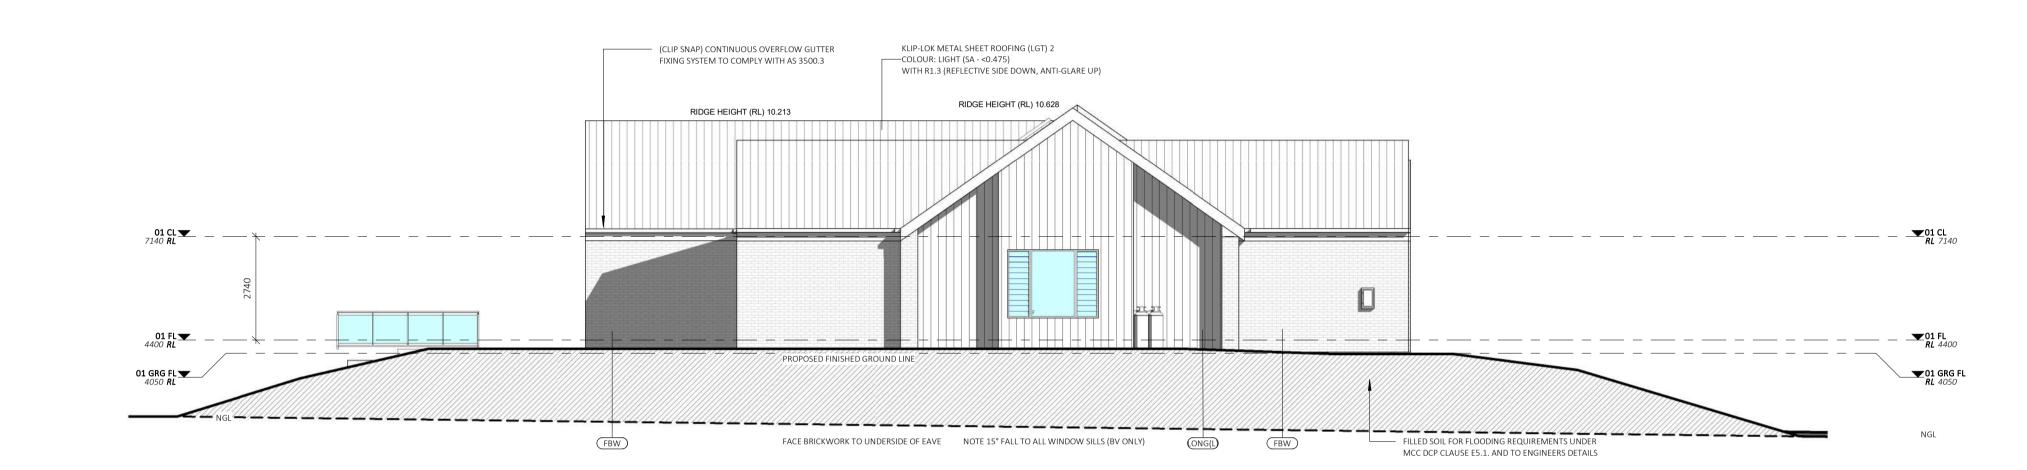U2 SOUTH ELEVATION

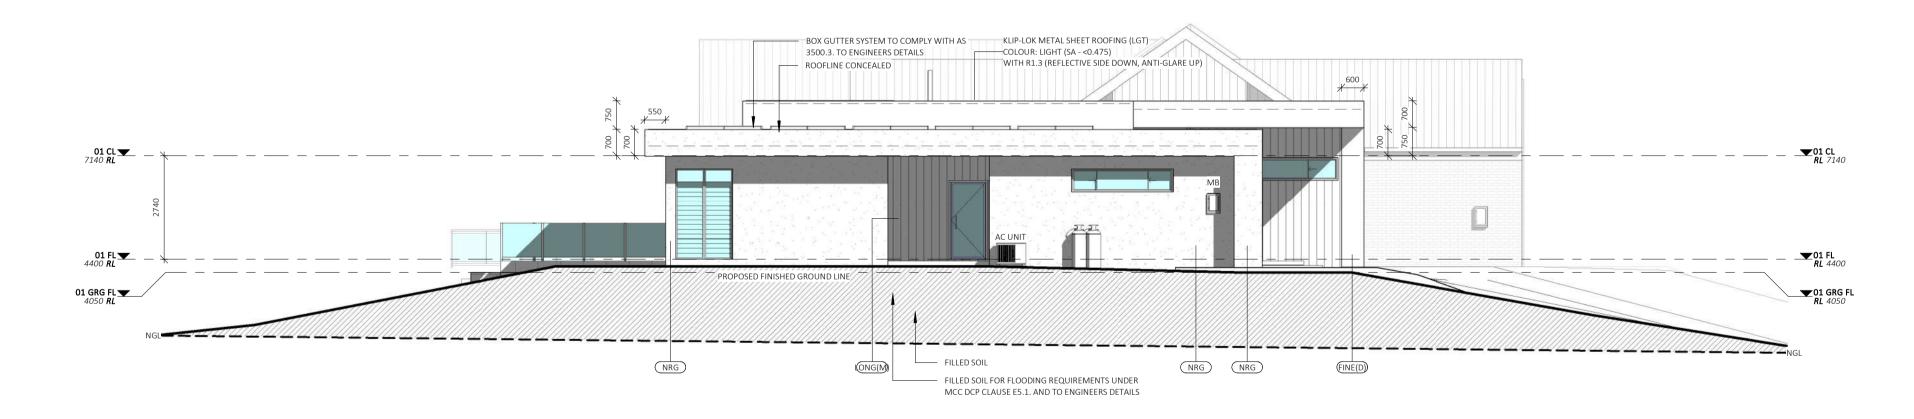

U1 SOUTH ELEVATION

1:100



HOUSING PROVISIONS AND IN ACCORDANCE WITH BARRIERS AND HANDRAILS TO BE NO LESS THAN 1000mm FROM PROPOSED FINISHED FL. BALUSTRADE & HANDRAIL TO BE IN ACCORDANCE WITH NCC, VOL. 2, H5D3 AND PARTS 11.3.3, 11.3.4, 11.3.5 AND 11.3.6 OF WINDOW NOTES: OUTSIDE • BARRIER TO BE MIN. 1200 POOL AREA FROM INSIDE POOL AREA FFL MIN 900mm GAP BETWEEN

CONSTRUCTION NOTES:

STAIRS, RAMPS, HANDRAILS & BALUSTRADE NOTES:

11.2.2 OF THE ABCB HOUSING PROVISIONS. RAMPS TO

AND RAMPS AS PER PART 11.2.4 OF THE ABCB

COMPLY WITH PART 11.2.3. SLIP RESISTANCE TO STAIRS

THE ABCB HOUSING PROVISIONS. BEDROOM WINDOWS - WHERE THE FLOOR LEVEL OF A BEDROOM IS 2M OR MORE ABOVE THE SURFACE BENEATH, BEDROOM WINDOWS ARE TO COMPLY WITH NCC, VOL. 2, H5P2 AND PART 11.3.7 OF THE ABCB

WINDOWS - WHERE THE FLOOR LEVEL IS 4m OR MORE ABOVE THE SURFACE BENEATH, WINDOWS ARE TO COMPLY WITH NCC, VOL. 2, H5P2 AND PART 11.3.8 OF AS 4055: WIND LOADS FOR HOUSING THE ABCB HOUSING PROVISIONS. BARRIER WITH A HEIGHT OF NOT LESS THAN 865mm AS 2047: WINDOWS & EXTERNAL DOORS IN BUILDING ABOVE FLOOR IS REQUIRED TO AN OPENABLE

(c) & 3.9.2.7 (b) WIND CATEGORY TO BE CONFIRMED PRIOR TO START OF CONSTRUCTION. IF N2 OR HIGHER, ENGAGED PIERS TO BRICKWORK AREA'S ARE TO

AS 1170-Part 2: WIND ACTIONS WINDOW TO COMPLY WITH VOL 2 NCC PART 3.9.2.6 AS 3959: CONSTRUCTION OF BUILDINGS IN BUSHFIRE *THE STANDARDS REFERRED ABOVE ARE THE VERSION

ONSTRUCTION CERTIFICATE OR COMPLYING COMPLY WITH AS 4773.1-2010 & AS 4773 2-2010 DEVELOPMENT CERTIFICATE APPLICATION IS MADE. **GENERAL PLAN SET NOTES:** PLEASE REFER TO THE "SUMMARY OF BASIX COMMITMENTS" ON PAGE 2 FOR

BCB HOUSING PROVISIONS.

GLAZING SPECIFICATIONS:

NSTALLED ON SITE

VINDOWS SPECIFIED USE NFRC UW & SHGCW VALUES.

NDARD GLAZING: SINGLE CLEAR GLAZING WITH ANDARD ALUMINIUM FRAMES THROUGHOUT

ASE NOTE: ALL GLAZING IN BATHROOMS, ENSUITES,

H1D8 AND PART 8.4.6 OF ABCB HOUSING PROVISIONS

EDROOM IS 2M OR MORE ABOVE THE SURFACE BENEATH

5P2 AND PART 11.3.7 OF THE ABCB HOUSING PROVISION

MPLY WITH NCC, VOL. 2, H5P2 AND PART 11.3.8 OF TH

BOVE FLOOR IS REQUIRED TO AN OPENABLE WINDOW TO

MPLY WITH VOL 2 NCC PART 3.9.2.6 (c) & 3.9.2.7 (b)

WINDOWS AND GLAZING TO COMPLY WITH:

AS 1288 : GLASS IN BUILDING - SELECTION & INSTALLATION

EDROOM WINDOWS ARE TO COMPLY WITH NCC, VOL. 2,

BOVE THE SURFACE BENEATH, WINDOWS ARE TO

ARRIER WITH A HEIGHT OF NOT LESS THAN 865mm

SPA ROOMS OR THE LIKE TO COMPLY WITH THE NCC, VOL

WINDOWS AS SPECIFIED OR EQUIVALENT MUST BE

CHECK ALL DIMENSIONS ON SITE. THIS DRAWING IS TO BE READ IN CONJUNCTION WITH ALL RELEVANT CONTRACTS, SPECIFICATIONS, REPORTS, DRAWINGS, LEGENDS, NATIONAL CONSTRUCTION CODE, AUS & NZ STANDARDS, ENGINEERING & COUNCIL APPROVALS

U2 NORTH ELEVATION 1:100

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STREET: 1-3 FERRY ROAD, OXLEY ISLAND I the dimensions on the job prior to neement of shop drawings or fabrication ncies to be referred to the consultant CLIENT: TICKLE & ROUND

PROJECT: DUAL OCCUPANCY (STRATA) STATUS: DA ISSUE **DP No:** 1297305

POOL AREA

NZ2 & NZ3

O BE CONSTRUCTED IN ACCORDANCE WITH

EXACT DETAILS

ELEVATIONS SHEET: 6 OF 8 SCALE: As indicated **START DATE**: 13.04.23 A5558 & A5563 DWG No:

UPPER AND LOWER

HORIZONTAL ELEMENTS

MAX 100mm GAP BETWEEN

VERTICAL ELEMENTS

MAX 100mm GAP BETWEEN

SURFACE AND BOTTOM OF

STEPS, RETAINING WALLS,

OBJECTS OR LEVEL CHANGE

TO BE 500mm FROM BARRIE

1800mm IN HEIGHT IF


FORMING POOL BARRIER

REFER TO AS1926.1 FOR

FURTHER INFORMATION. PLEASE REFER TO THE BASIX CERTIFICATE FOR

SHEET SIZE: DRAWING REVISIONS + NOTES 04.08.23 INITIAL ISSUE 10.10.23 REVISED 07.12.23 DA ISSUE

11.12.23 DA ISSUE 18.12.23 DA ISSUE REV

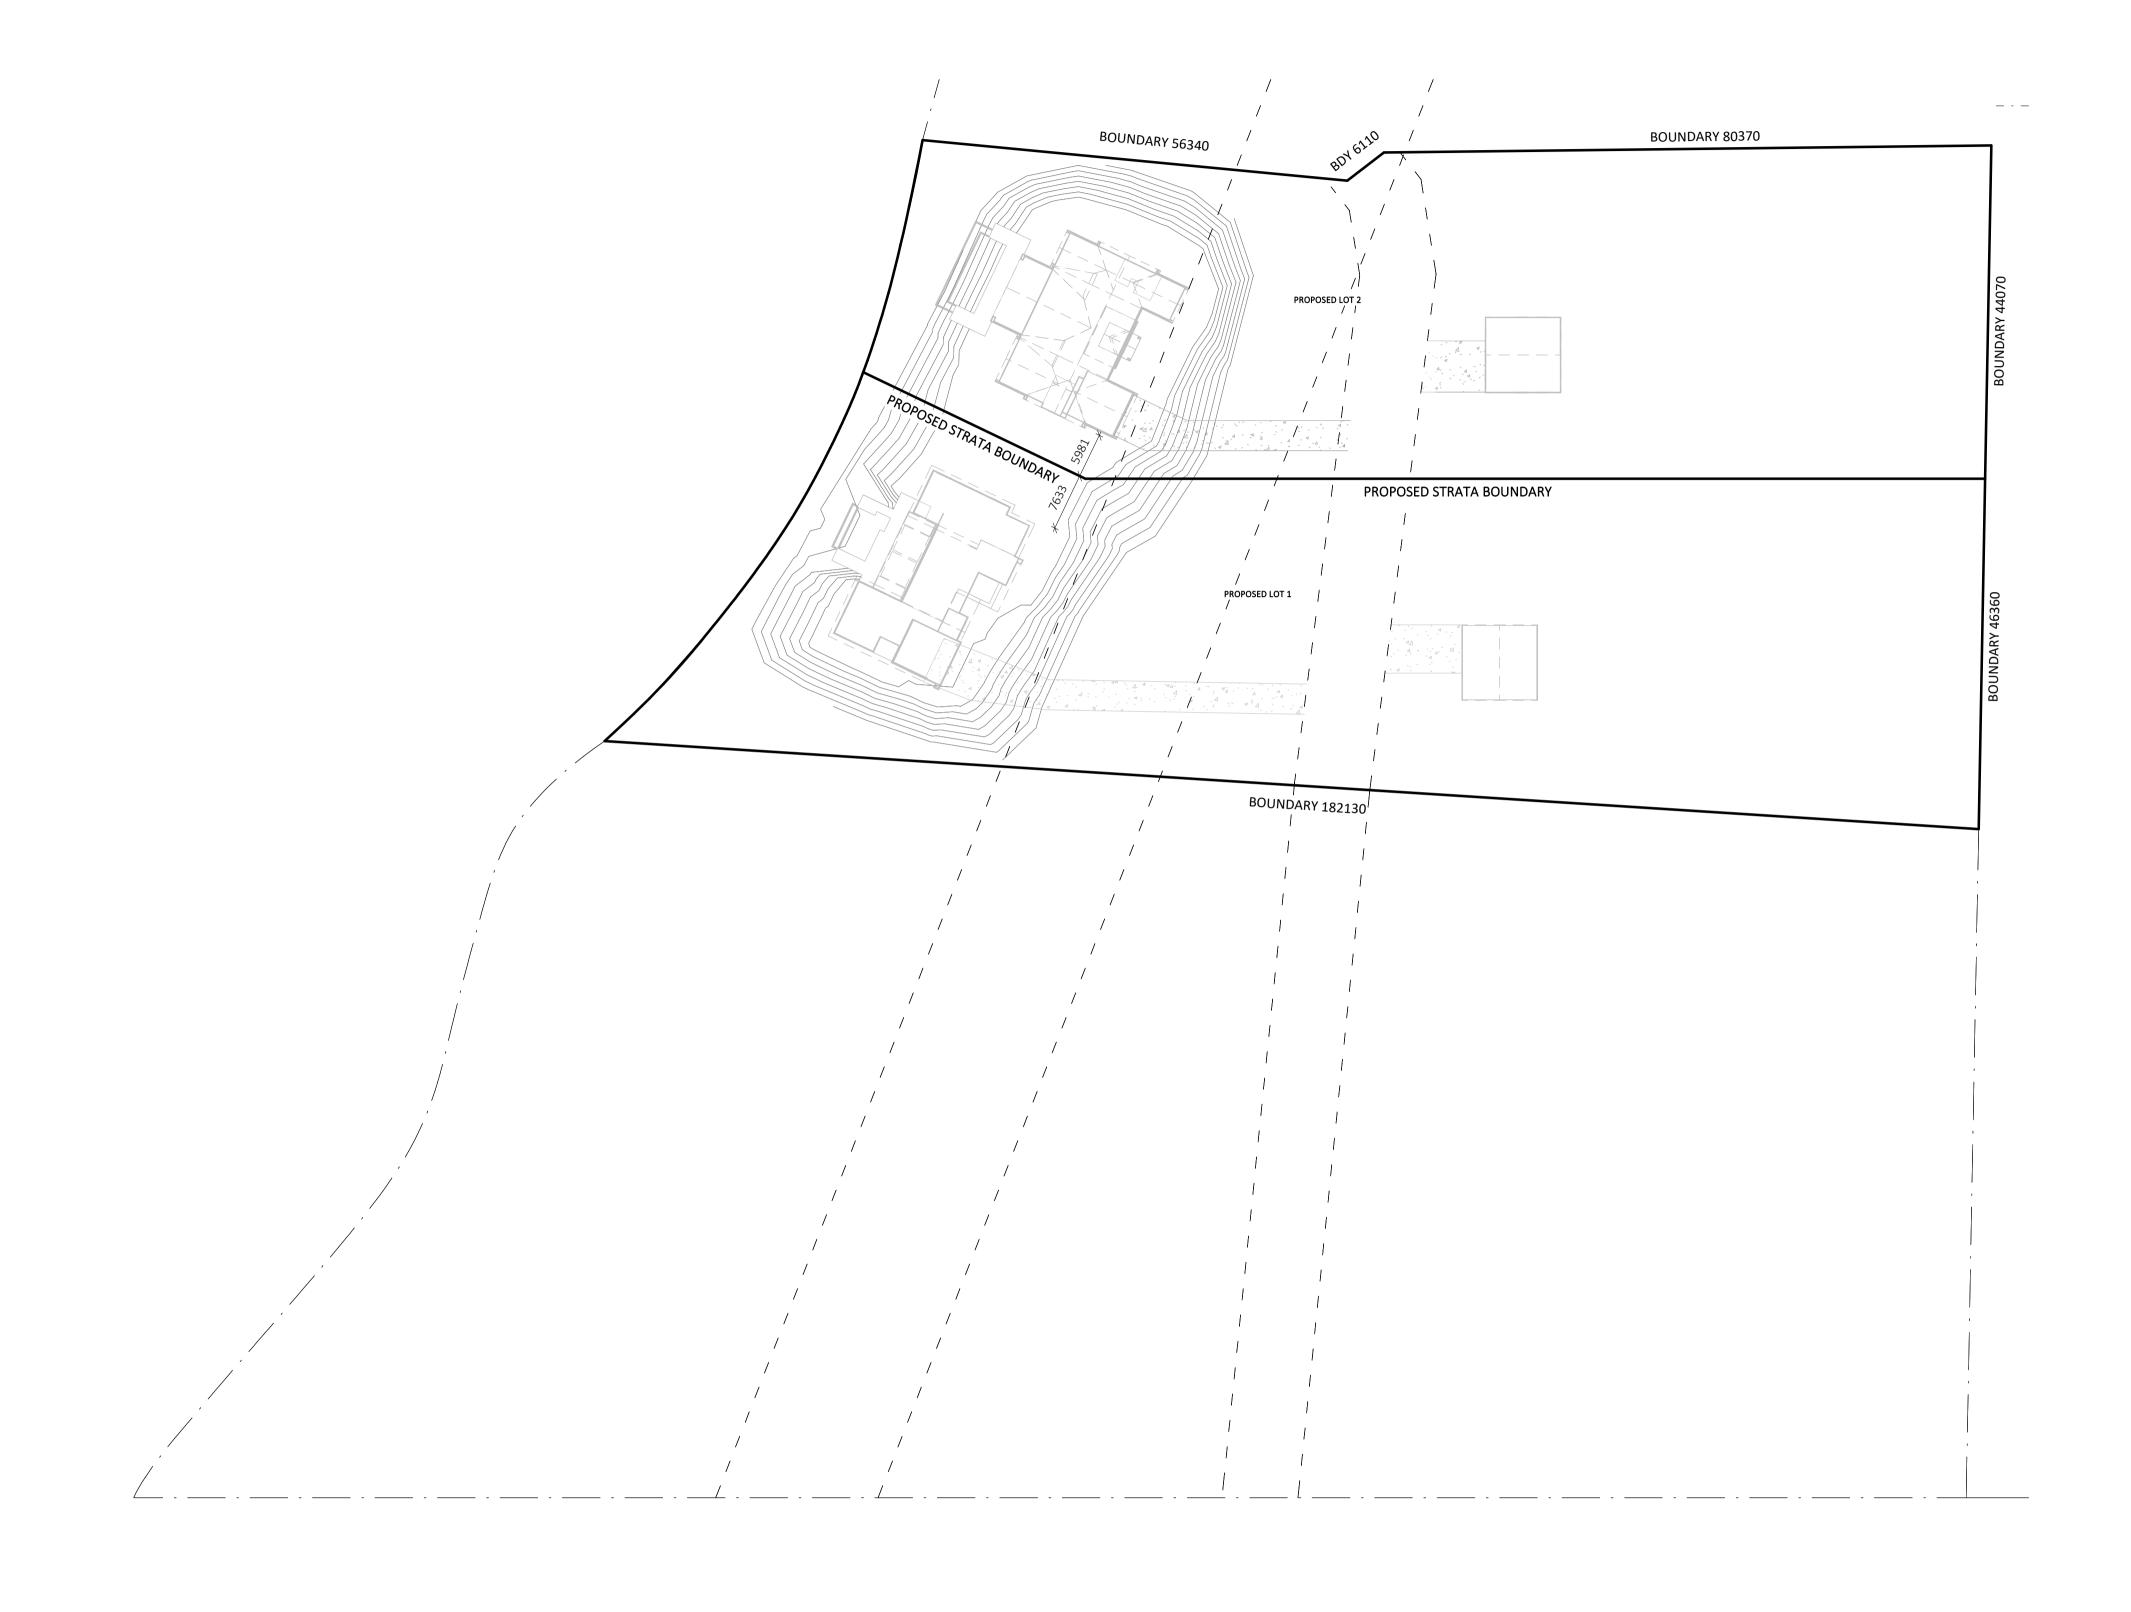



SITE DRAFT SUB-DIVISION PLAN

1:500

	10 STA		ABSA
			Australian Building Sustainability Association
			Assessments completed within the accreditation period are part of the ABSA quality audit system
			Accreditation Period 03/09/2023-03/09/2024
			Assessor Name Adam Clarke
Cert	ificate No. #HF	R-KVRRMH-	Assessor Number 101518
HOUSE 03			
Scan QR	code or follow website link Adam Clarke	for rating details.	Assessor Signature
Accreditation No.	ABSA 101518	(E19)	
		100 H	is qualified to use Nathers Accredited Software and has agreed to follow the ABSA Coste of Practice


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NAMES OF STREET	[DA ISSUE ONLY	/	
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	89A Lord Street (PO Box 5667), Port Maco	quarie NSW 2444 Shop 17 Centrepoin	t Arcade, Taree NSW 24	430

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L١	NOT BUSHFIRE AFFECTED N/A	PLEASE REFER TO THE "SUMMARY OF BASIX COMMITMENTS" ON PAGE 2 FO FURTHER INFORMATION. PLEASE REFER TO THE BASIX CERTIFICATE FOR EXACT DETAILS			
D ie	PROJECT: DUAL OCCUPANCY (STRATA)	DRAFT SUB-DIVISION	SHEET SIZE:		


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				START DATE:	13.04.23	\wedge	11.12.23	DA ISSUE	E	

DWG No: A5558 & A5563

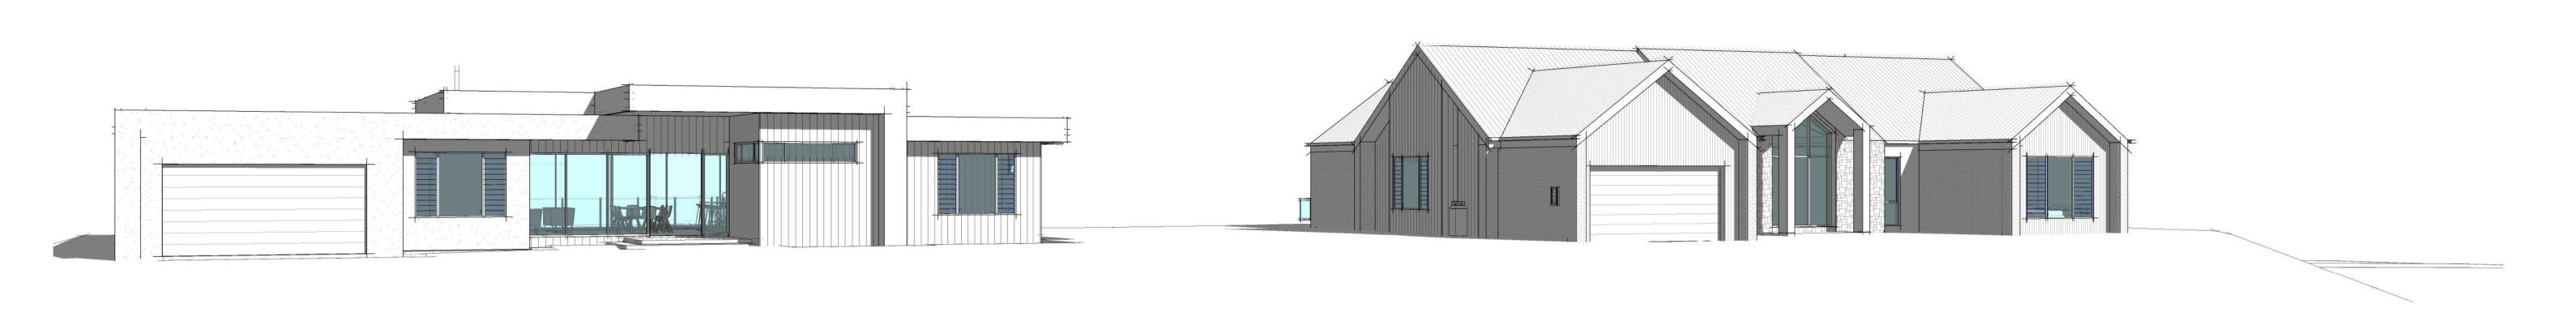

3D View 1

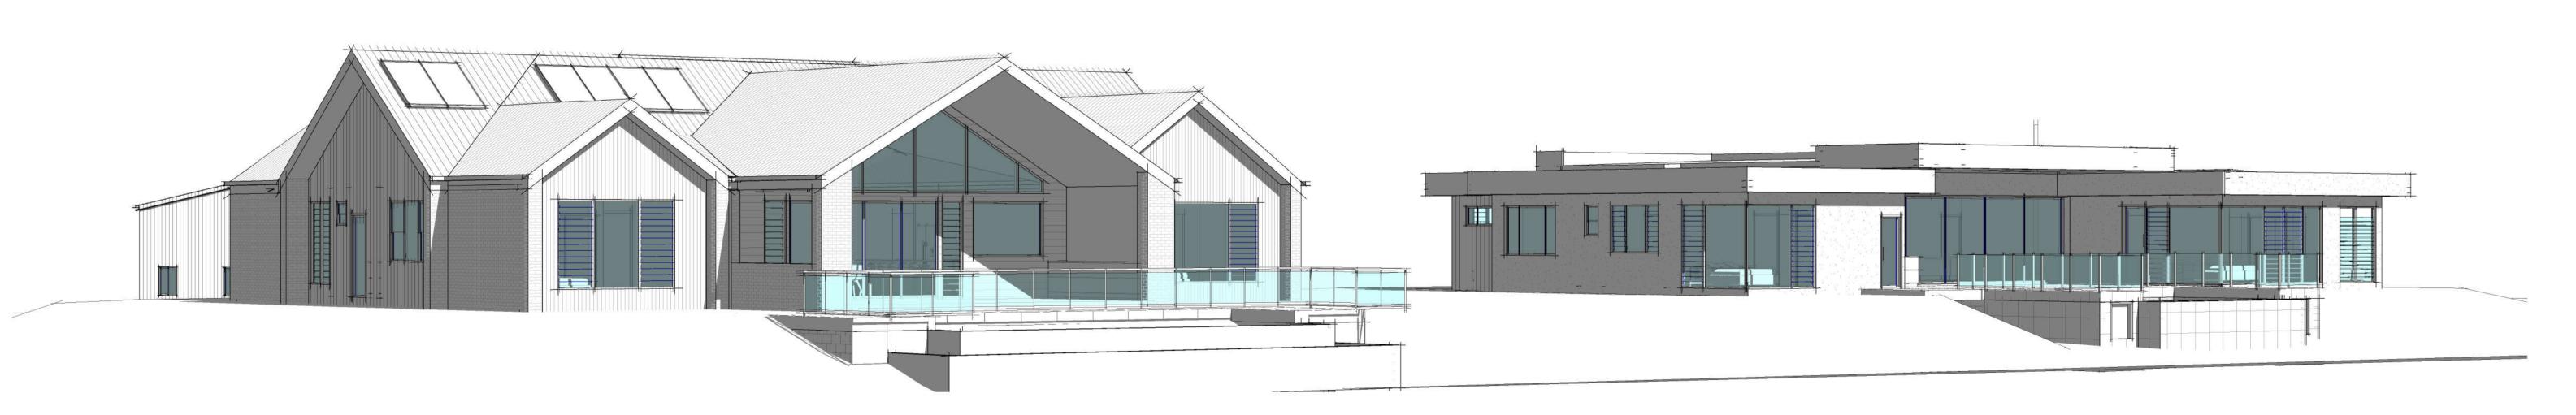

3D View 2



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Discrepancies to be referred to the consultant Designer prior to commencement of work.	CLIENT: TICKLE & ROUND		DWG No:	A5558 & A5563		18.12.23 DA ISSUE REV